# PROPOSED SHED AT SYDNEY RECYCLING PARK LOT 230 DP 1134016 16 - 23 CLIFTON AVENUE, KEMPS CREEK CONCEPT CIVIL ENGINEERING DRAWINGS

# DRAWINGS LIST

C1.00 COVER SHEET C1.01 KEY PLAN

22.00 SEDIMENT AND EROSION CONTROL PLAN
22.01 SEDIMENT AND EROSION CONTROL DETAILS

C3.00 CONCEPT BULK EARTHWORKS PLAN

C3.01 CONCEPT SITE SECTIONS

C4.00 CONCEPT STORMWATER MANANGEMENT PLAN
C4.01 CONCEPT STORMWATER MANAGEMENT DETAILS

C5.00 CONCEPT DRIVEWAY PLAN AND LONG SECTION

### NOTE

- THIS IS AN ENGINEERING SURVEY PLAN AND SHALL NOT BE TAKEN AS A CADASTRA OR IDENTIFICATION SURVEY. BOUNDARY DATA IF SHOWN, SHOULD BE TAKEN AS A GUIDE ONLY
- 2. REFER TO THE CERTIFICATE OF TITLE FOR EASEMENT DETAILS (IF ANY).
  3. NO UNDERGROUND SERVICES HAVE BEEN LOCATED.
- . NO UNDERGROUND SERVICES HAVE BEEN LOCATEL

### SURVEY:

- SURVEY PROVIDED BY: MATHEW FREEBURN SURVEYORS REF: 31209 DATED 28/0/21 & 16/05/22
- 2. ORIGIN OF LEVELS .

PM / SSM	EASTING	NORTHING	RL(AHD)
NA	NA	NA	NA

### ARCHITECTURAL PLANS BY:

ARCHITECTURAL PLANS BY: APEX BUILDING SERVICES, REF: 2064, REVISION/VERSION: E, DATED: 20/07/22.

### **GEOTECH ENGINEER:**


GEOTECH REPORT BY: CONSULTING EARTH SCIENTISTS, REF: CES220320-WAE-AC, DATED 13/07/22.









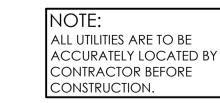



REISSUE FOR DA IS.O C 16.02.23
ISSUED FOR REVIEW IS.O B 15.02.23
ISSUED FOR DA CW A 10.08.22
AMENDMENTS DATE ISSUE BY

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ENVIRONMENTAL AND PLANNING
SYDNEY RECY
16-23 CLIFTON AVE

SYDNEY RECYCLING PARK 16-23 CLIFTON AVE KEMPS CREEK NSW

DRAWN DATE SIZE CAD REF

CW AUG 22 A1 TX16593.00 - C1




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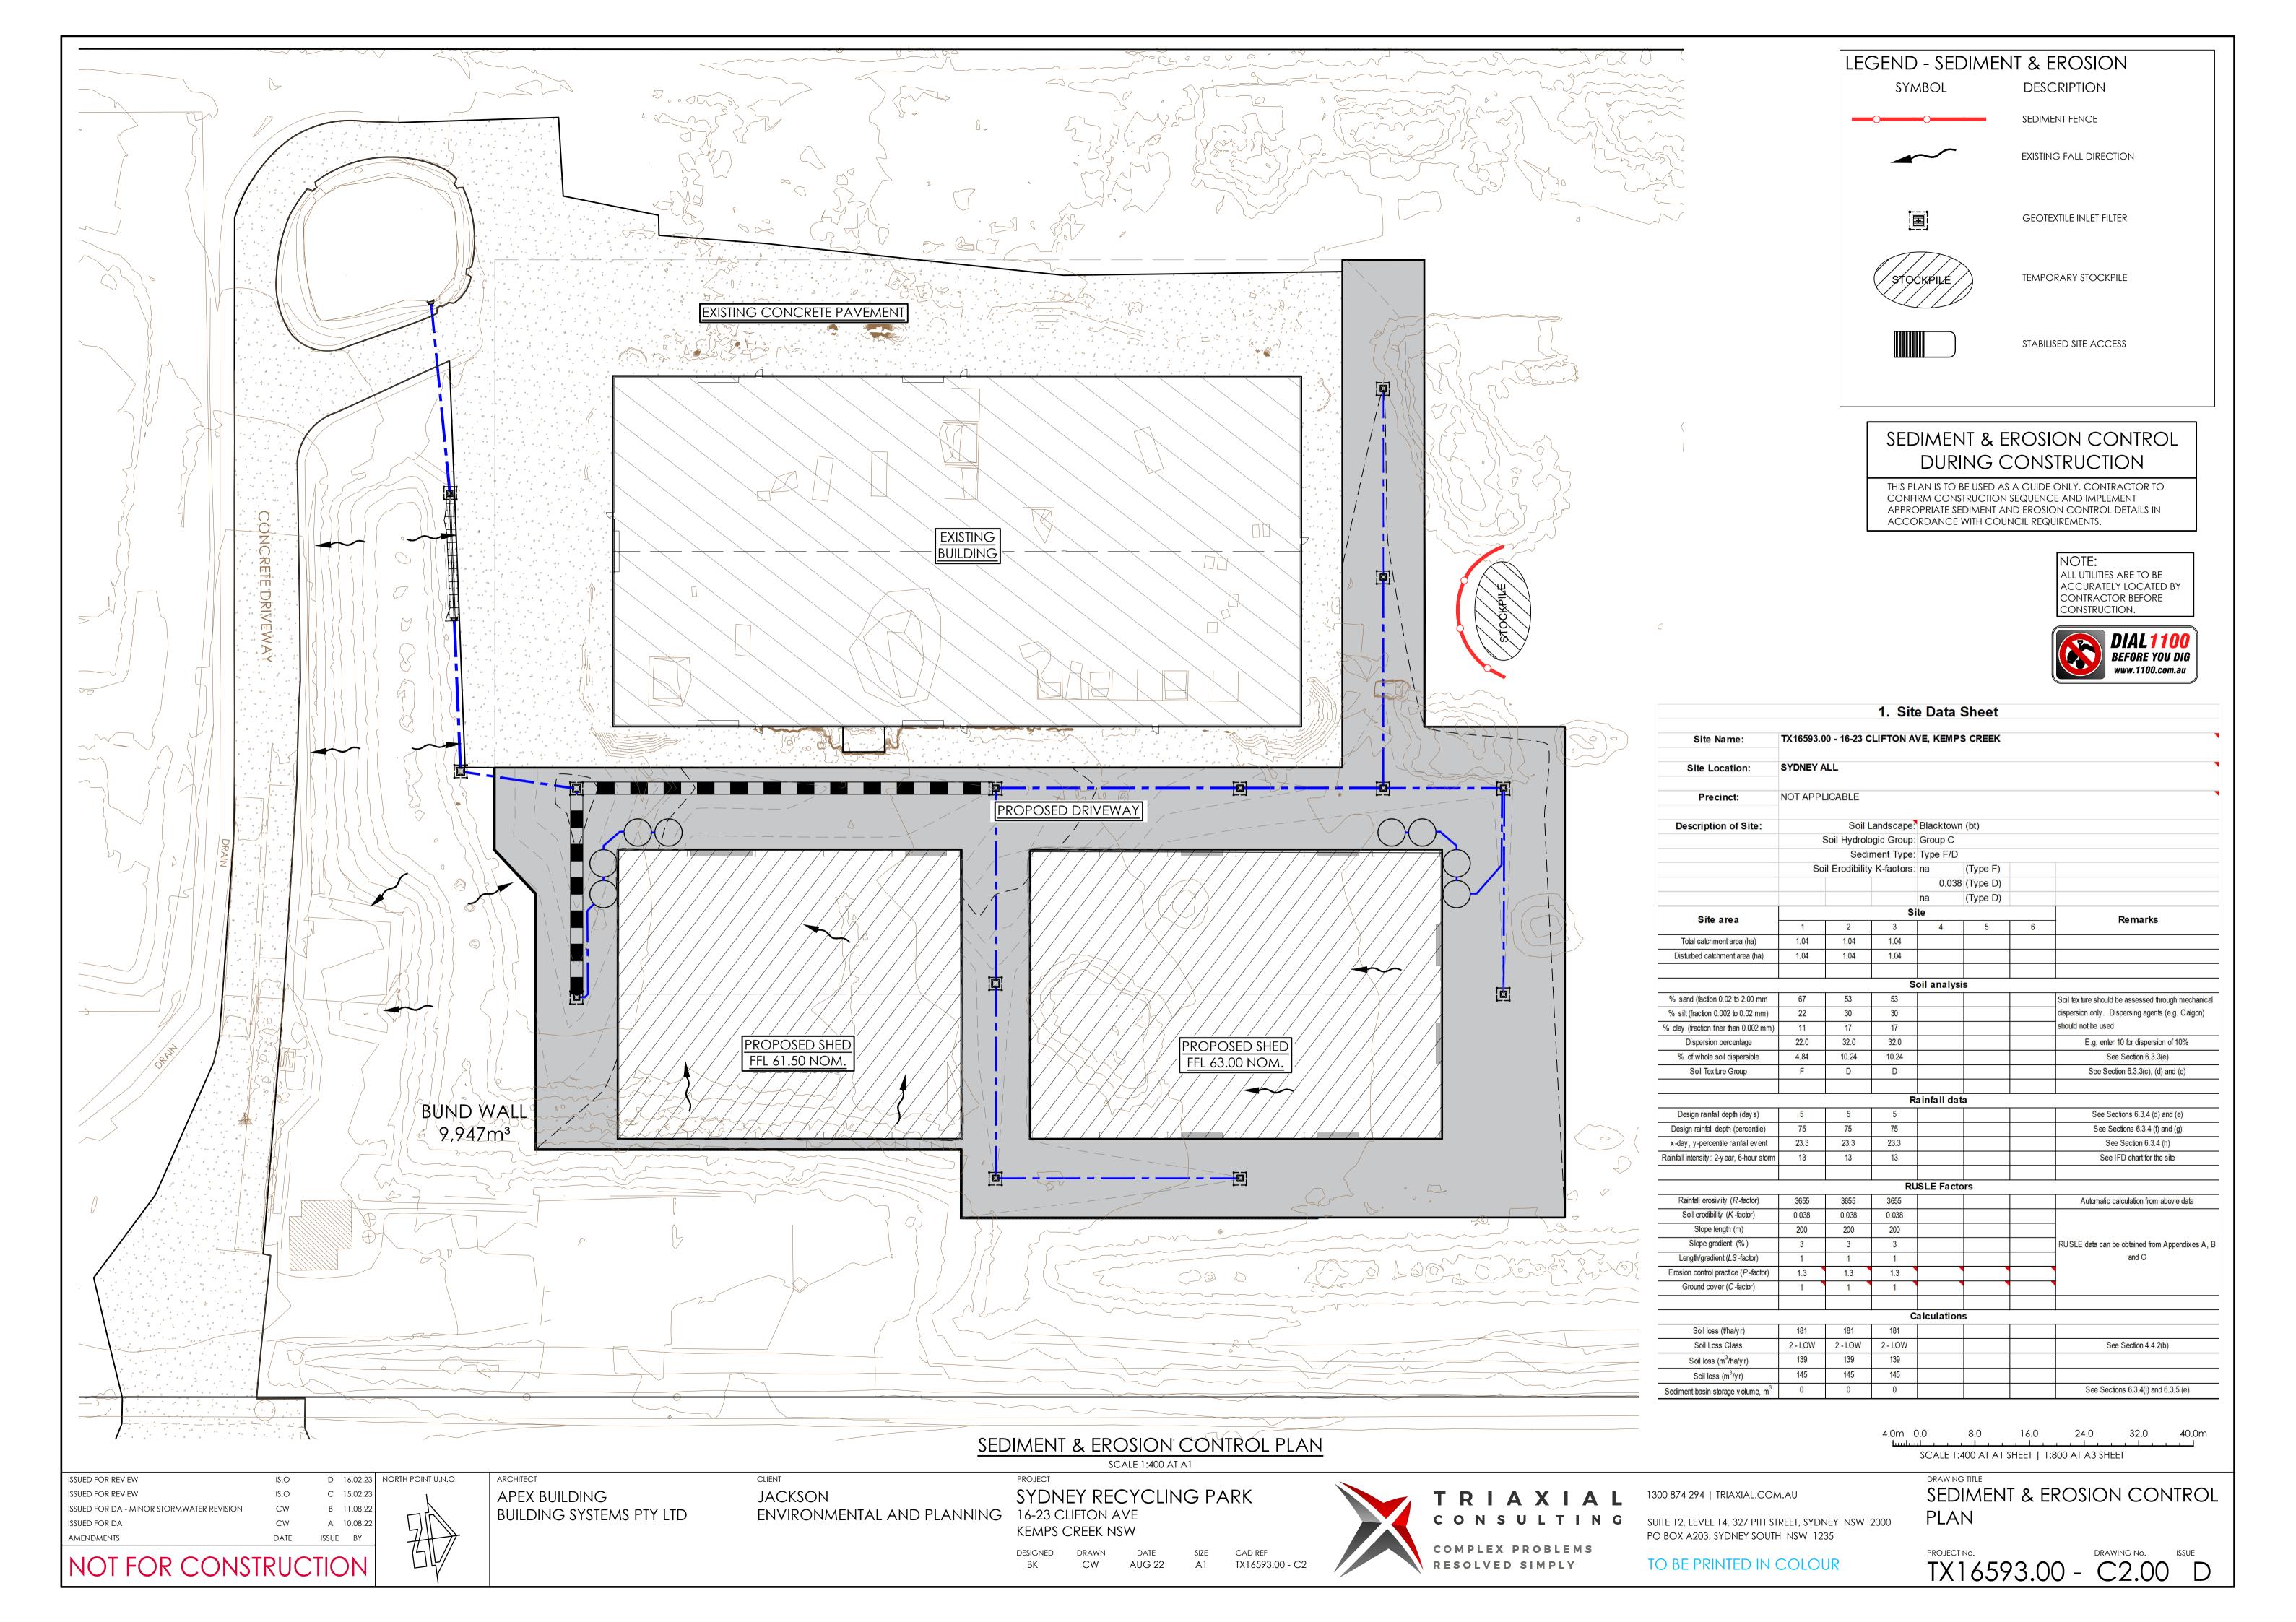
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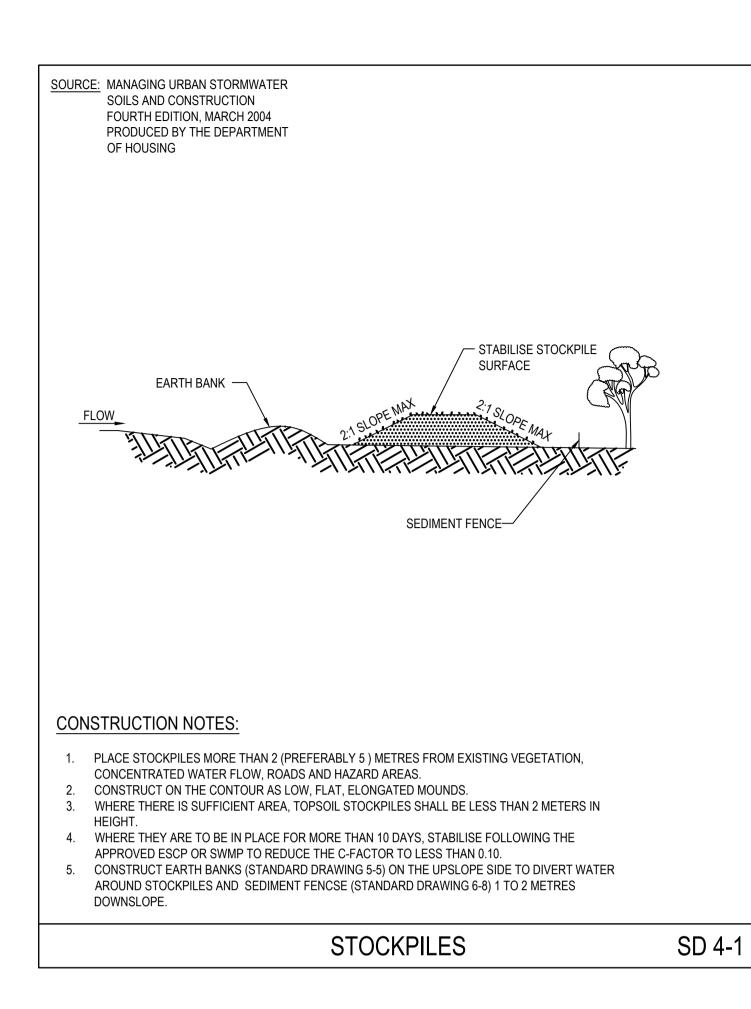
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SUITE 12, LEVEL 14, 327 PITT STREET, SYDNEY NSW 2000
PO BOX A203, SYDNEY SOUTH NSW 1235
COMPLEX PROBLEMS


COVER SHEET

TX16593.00 - C1.00 C





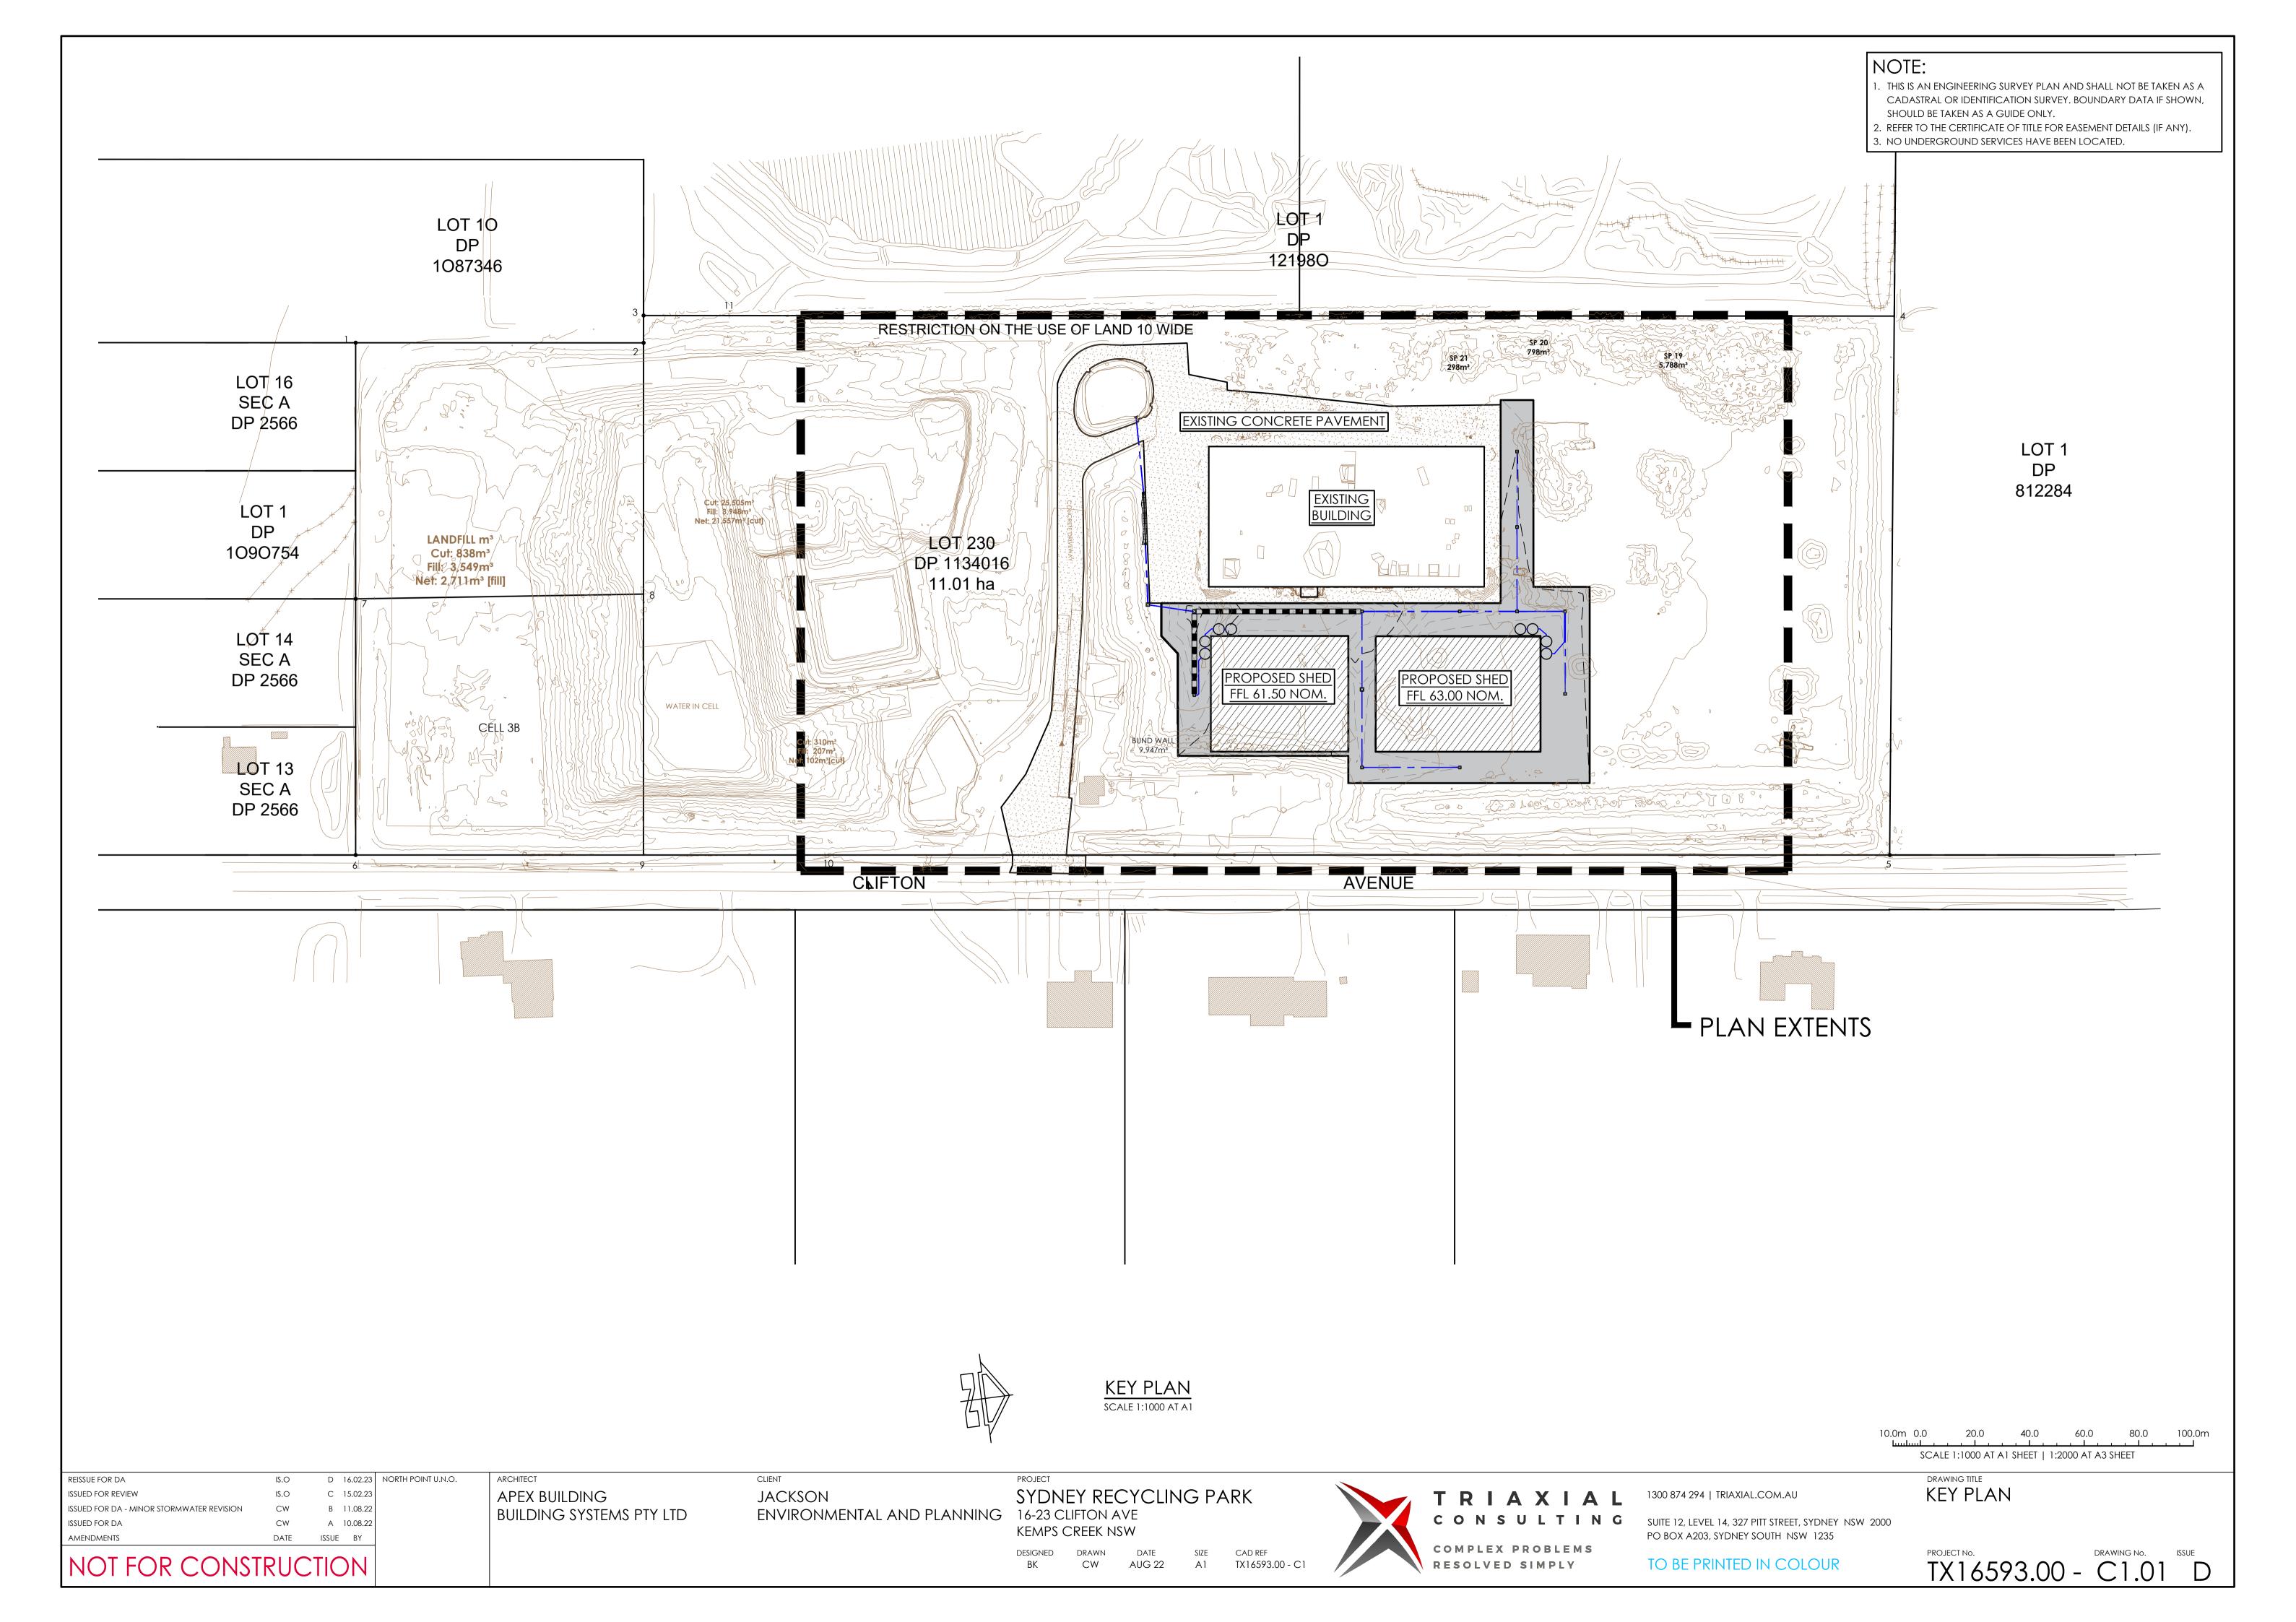

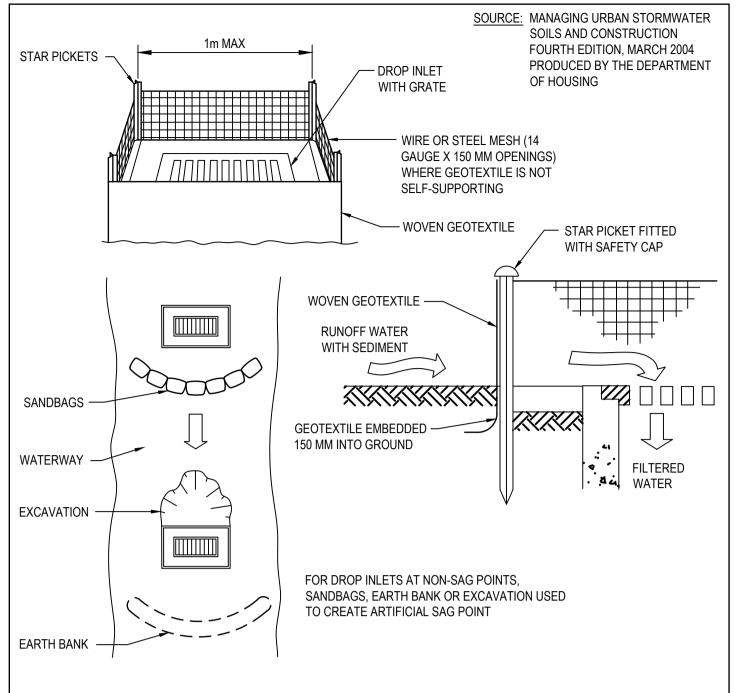


### **CONSTRUCTION NOTES:**


- FABRICATE A SEDIMENT BARRIER MADE FROM GEOTEXTILE OR STRAW BALES.
- FOLLOW STANDARD DRAWING 6-7 AND STANDARD DRAWING 6-8 FOR INSTALLATION PROCEDURES FOR THE STRAW BALES OR GEOFABRIC. REDUCE THE PICKET SPACING TO 1 METRE CENTRES.
- 3. IN WATERWAYS, ARTIFICIAL SAG POINTS CAN BE CREATED WITH SANDBAGS OR EARTH BANKS AS SHOWN IN THE
- 4. DO NOT COVER INLET WITH GEOTEXTILE UNLESS THE DESIGN IS ADEQUATE TO ALLOW FOR ALL WATERS TO BYPASS


### GEOTEXTILE INLET FILTER SD 6-12

DIVERT WATER TO THE SEDIMENT FENCE

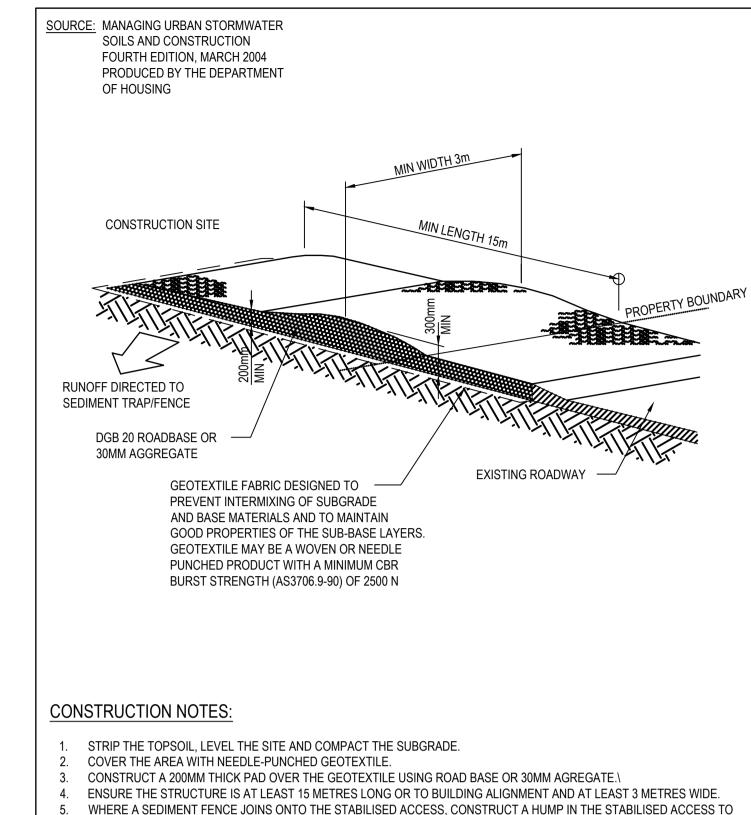

STABILISED SITE ACCESS - IF REQUIRED SD 6-14

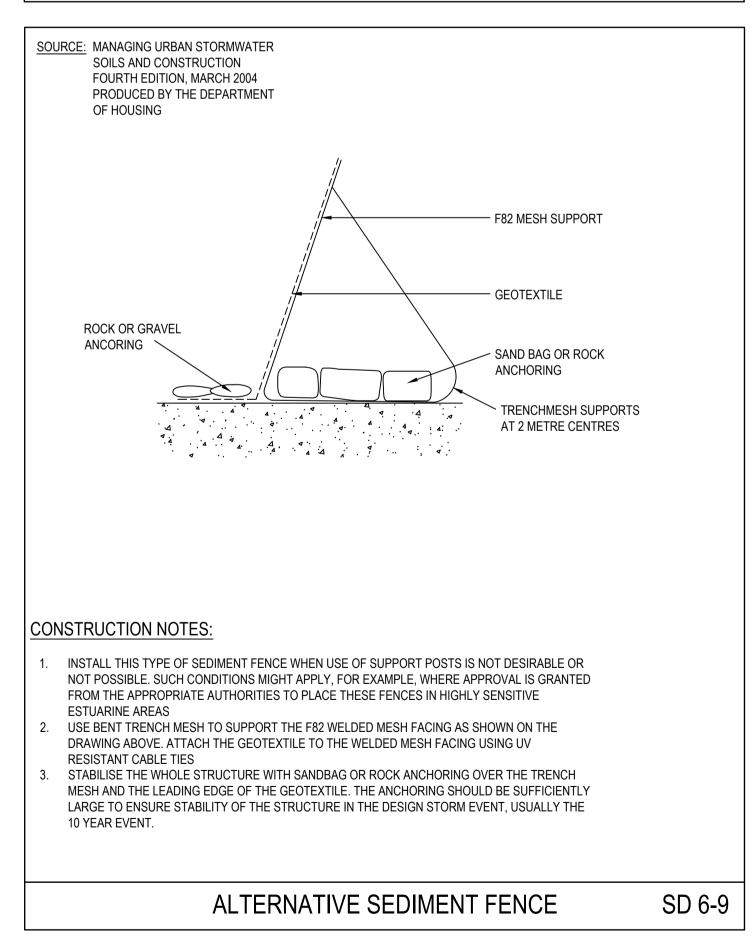

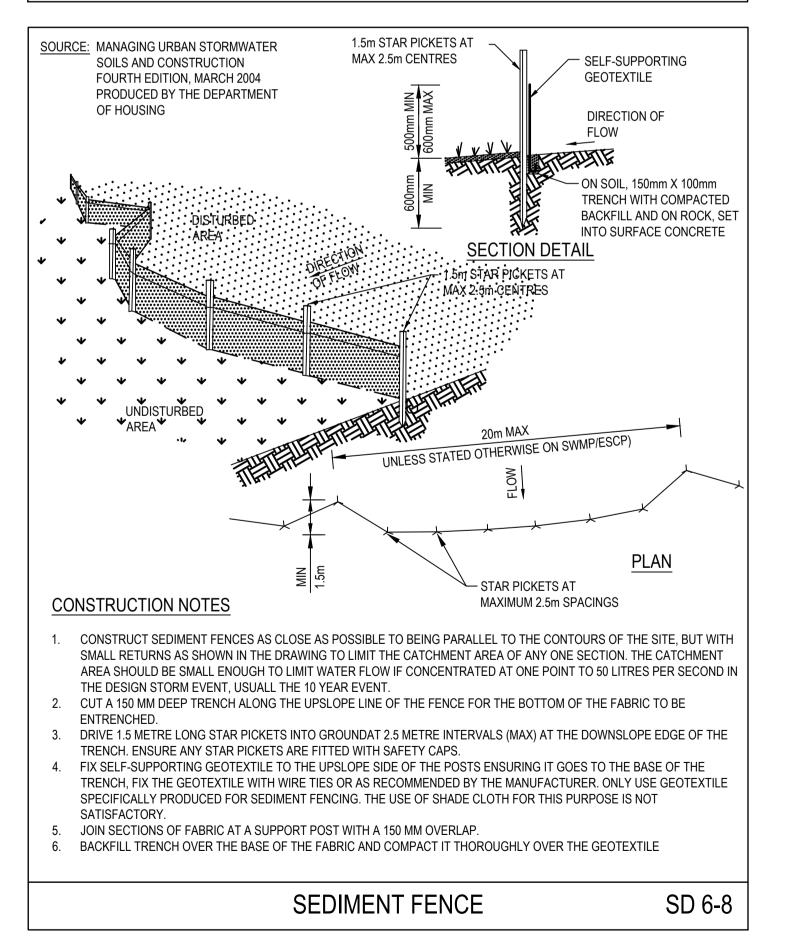

REISSUE FOR DA B 16.02.23 ISSUED FOR DA A 10.08.22 DATE ISSUE BY **AMENDMENTS** NOT FOR CONSTRUCTION

**ARCHITECT** APEX BUILDING BUILDING SYSTEMS PTY LTD

**JACKSON** ENVIRONMENTAL AND PLANNING 16-23 CLIFTON AVE

SYDNEY RECYCLING PARK

KEMPS CREEK NSW DESIGNED SIZE DRAWN CW AUG 22 A1 TX16593.00 - C2




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SEDIMENT & EROSION CONTROL **DETAILS** 

DRAWING No. TX16593.00 - C2.01 B



T FINISHED SURFACE LEVEL (FSL) 
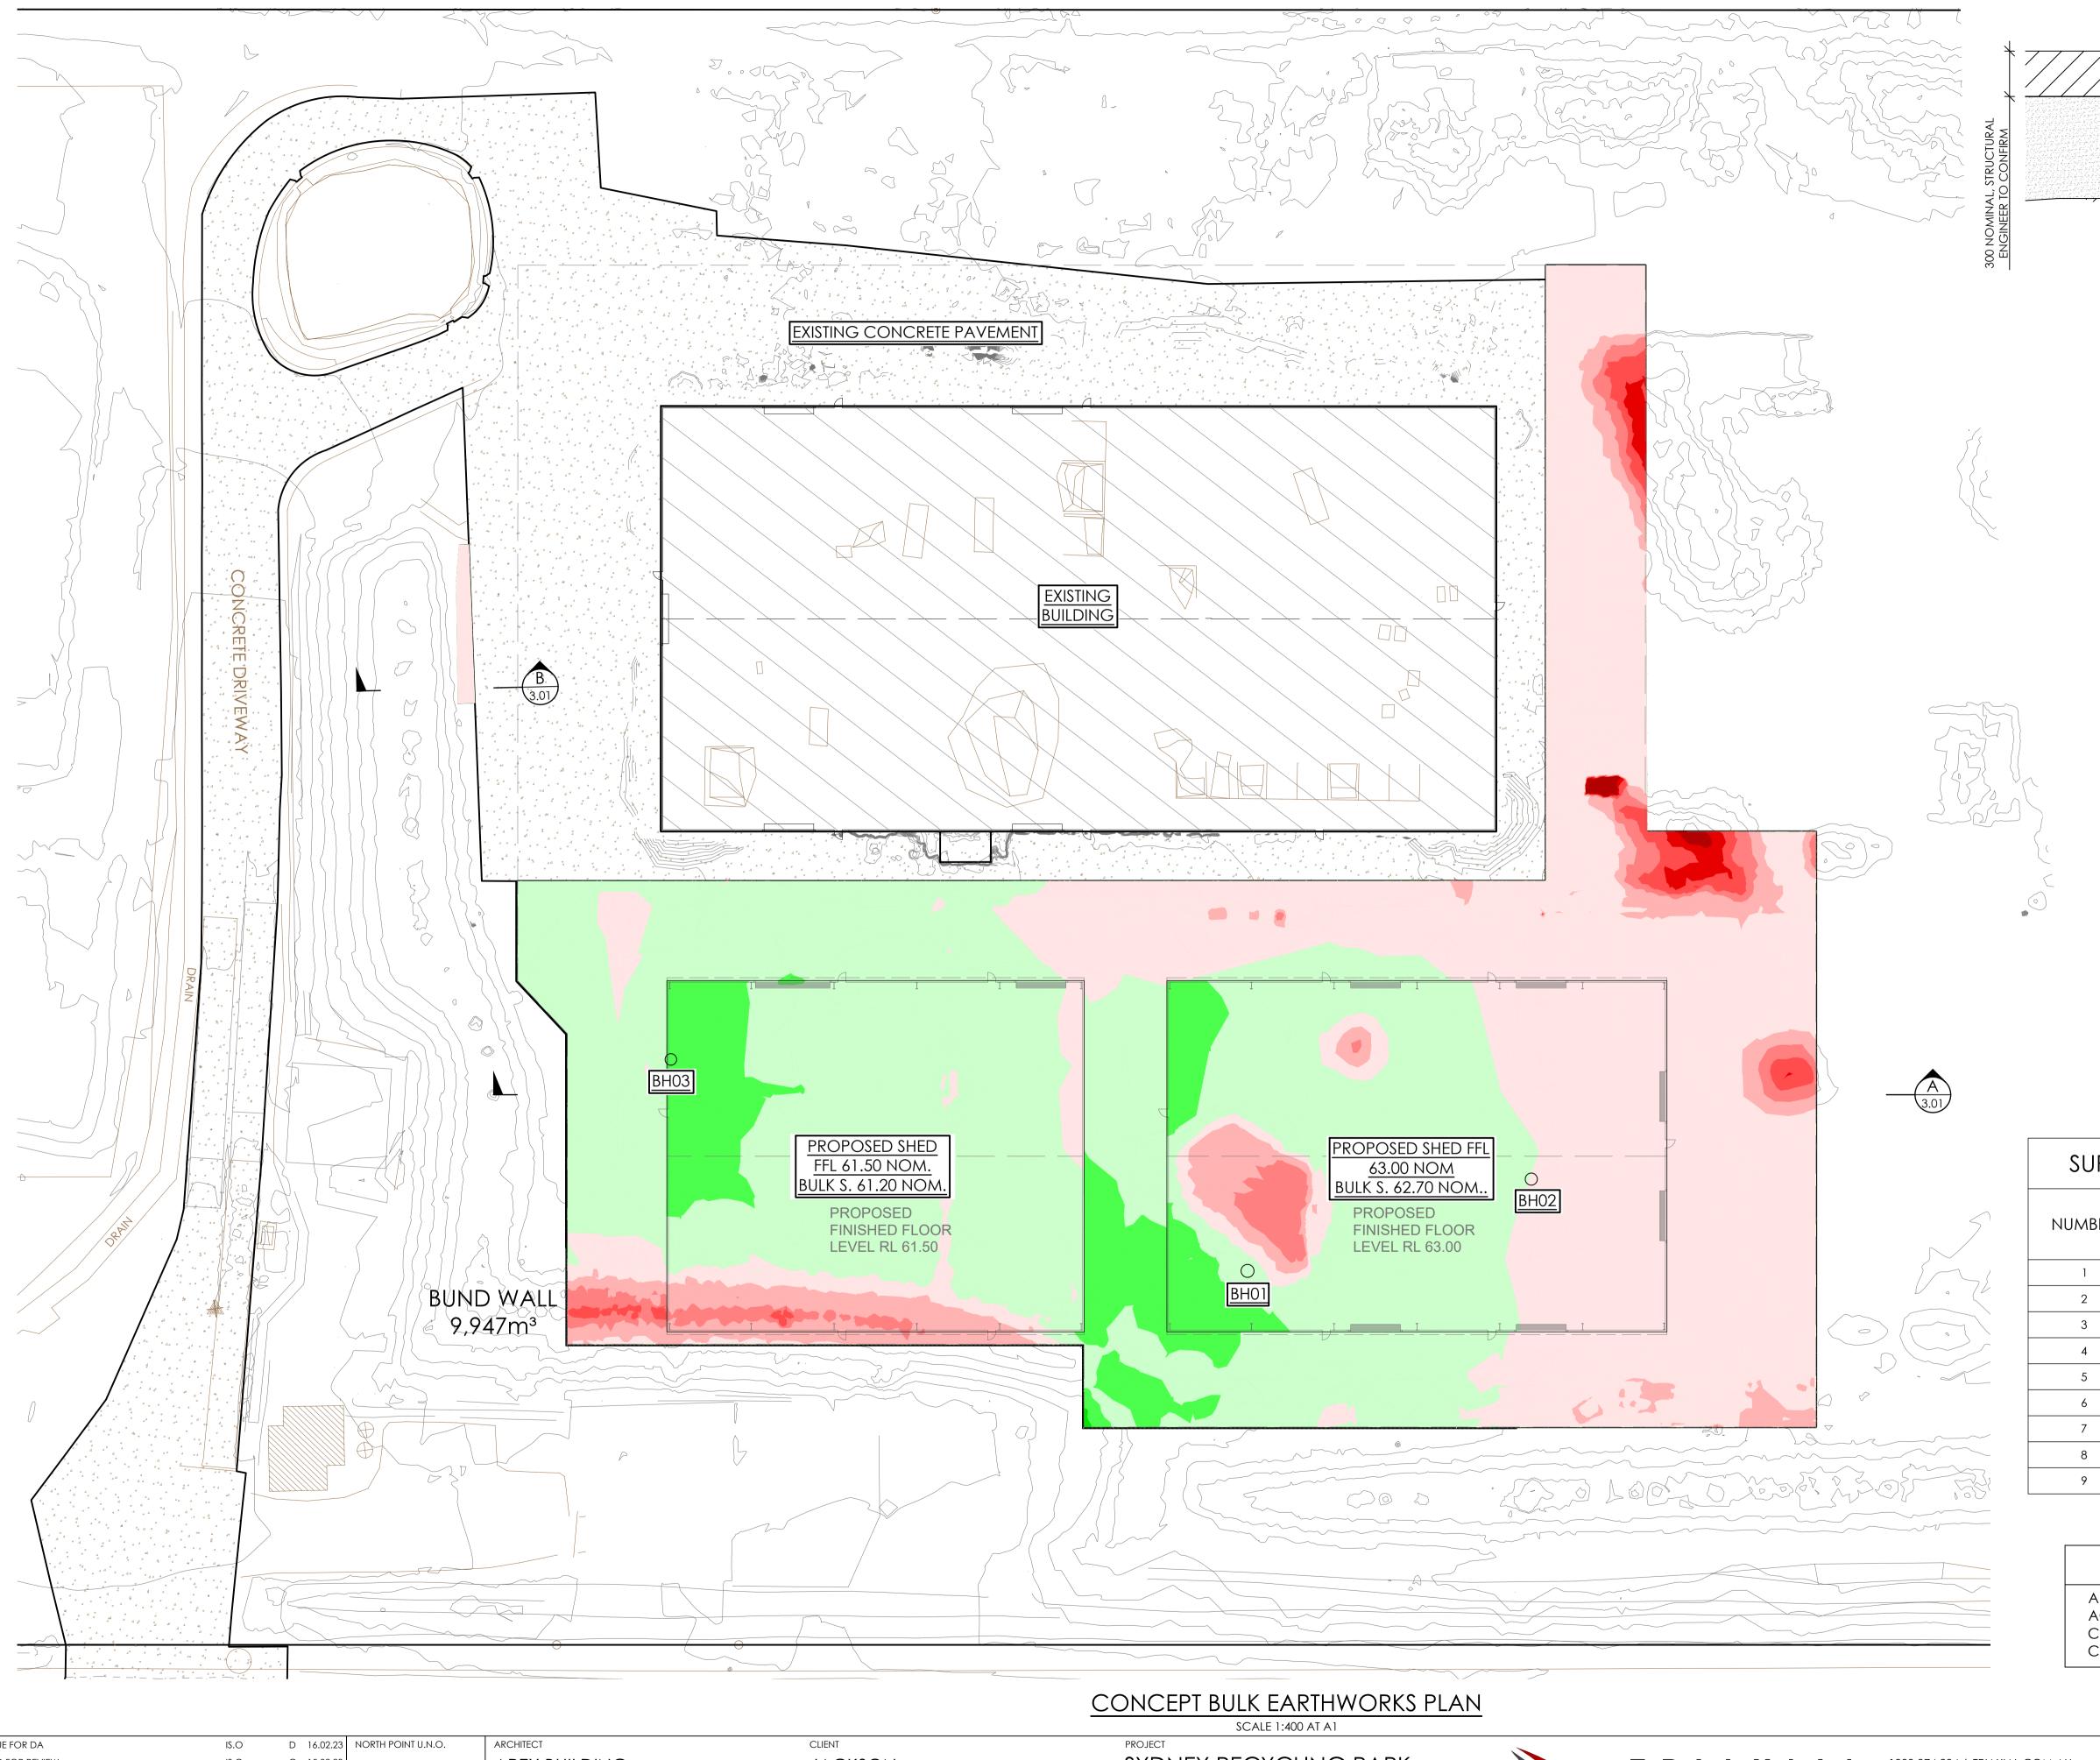
> FILL (REFER TO GEOTECHNICAL **ENGINEERS** RECOMMENDATIONS)

- EXISTING SURFACE, VARIES

### CONCEPT BULK EARTHWORKS DETAIL

SCALE NTS

\* BULK EARTHWORKS LEVEL IS SUBJECT TO SLAB AND BEDDING DESIGN BY STRUCTURAL ENGINEER. 300mm DEPTH HAS BEEN ADOPTED FOR THE PURPOSE OF PRODUCING CONCEPT VOLUME CALCULATIONS

### ALLOTMENT FILLING

ALL ALLOTMENT FILLING TO BE PLACED & COMPACTED AS SPECIFIED AND CONFORMING TO AS2870 - LEVEL 2 SUPERVISION (UNO).

### **EARTHWORKS**

- THIS PLAN IS TO BE COORDINATED WITH THE STRUCTURAL ENGINEERS DETAILS AND SPECIFICATIONS AT CONSTRUCTION CERTIFICATE AND DETAILED DESIGN
- 2. TRIAXIAL CONSULTING HAVE CREATED A 3D MODEL TO GENERATE THE CONCEPT DESIGN AND EARTHWORKS SURFACES. THE MODEL HAS BEEN CREATED FOR DESIGN PURPOSES ONLY. ANY DIGITAL FILES ISSUED BY TRIAXIAL FOR THIS PROJECT ARE FOR INFORMATION ONLY AND ARE NOT TO BE USED AS A CONSTRUCTION MODEL OR FOR FINAL SETOUT. ALL FILES PROVIDED ARE TO BE VERIFIED BY A REGISTERED SURVEYOR PRIOR TO UNDERTAKING ANY SETOUT.

# CONCEPT EARTHWORKS **VOLUMES**

VOLUMES HAVE BEEN TAKEN FROM 300mm BELOW THE NOMINATED FINISHED SURFACE LEVELS (ASSUMED 200TK REINFORCED CONCRETE SLAB + 100TK BEDDING). FINAL PROFILING TO BE CONFIRMED.

BULK EARTHWORKS CALCULATIONS EXCLUDE OVER EXCAVATION AND FILL PAVEMENT WITH REGARD TO LANDFILL LAYER INTERACTION. REFER TO SHEET C3.01 AND GEOTECHNICAL REPORT

THE VALUES BELOW ARE CONCEPTUAL AND ARE SUBJECT TO GEOTECHNICAL ENGINEERS RECOMMENDATIONS AND STRUCTURAL SLAB DETAILS.

TOTAL CUT= 4023m<sup>3</sup> CUT TO FILL=2981 m<sup>3</sup> IMPORT FILL= 1042m<sup>3</sup>

## SURFACE ANALYSIS: ELEVATION RANGES

301(17(CE7(14)(E13)3: EEE 47(110111(7(140E3			
NUMBER	COLOUR	MINIMUM ELEVATION (m)	MAXIMUM ELEVATION (m)
1		-5.901	-5.000
2		-5.000	-4.000
3		-4.000	-3.000
4		-3.000	-2.000
5		-2.000	-1.000
6		-1.000	0.000
7		0.000	1.000
8		1.000	2.000
9		2.000	2.200

NOTE

ALL UTILITIES ARE TO BE ACCURATELY LOCATED BY CONTRACTOR BEFORE CONSTRUCTION.



REISSUE FOR DA ISSUED FOR REVIEW C 15.02.23 ISSUED FOR DA - MINOR STORMWATER REVISION

B 11.08.22 A 10.08.22 ISSUE BY

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CONCEPT BULK EARTHWORKS PLAN


SCALE 1:400 AT A1 SHEET | 1:800 AT A3 SHEET


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2.5m 0.0 5.0 10.0 15.0 20.0 25.0m SCALE 1:250 AT A1 SHEET | 1:500 AT A3 SHEET

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KEMPS CREEK NSW

SYDNEY RECYCLING PARK 16-23 CLIFTON AVE KEMPS CREEK NSW

DATE

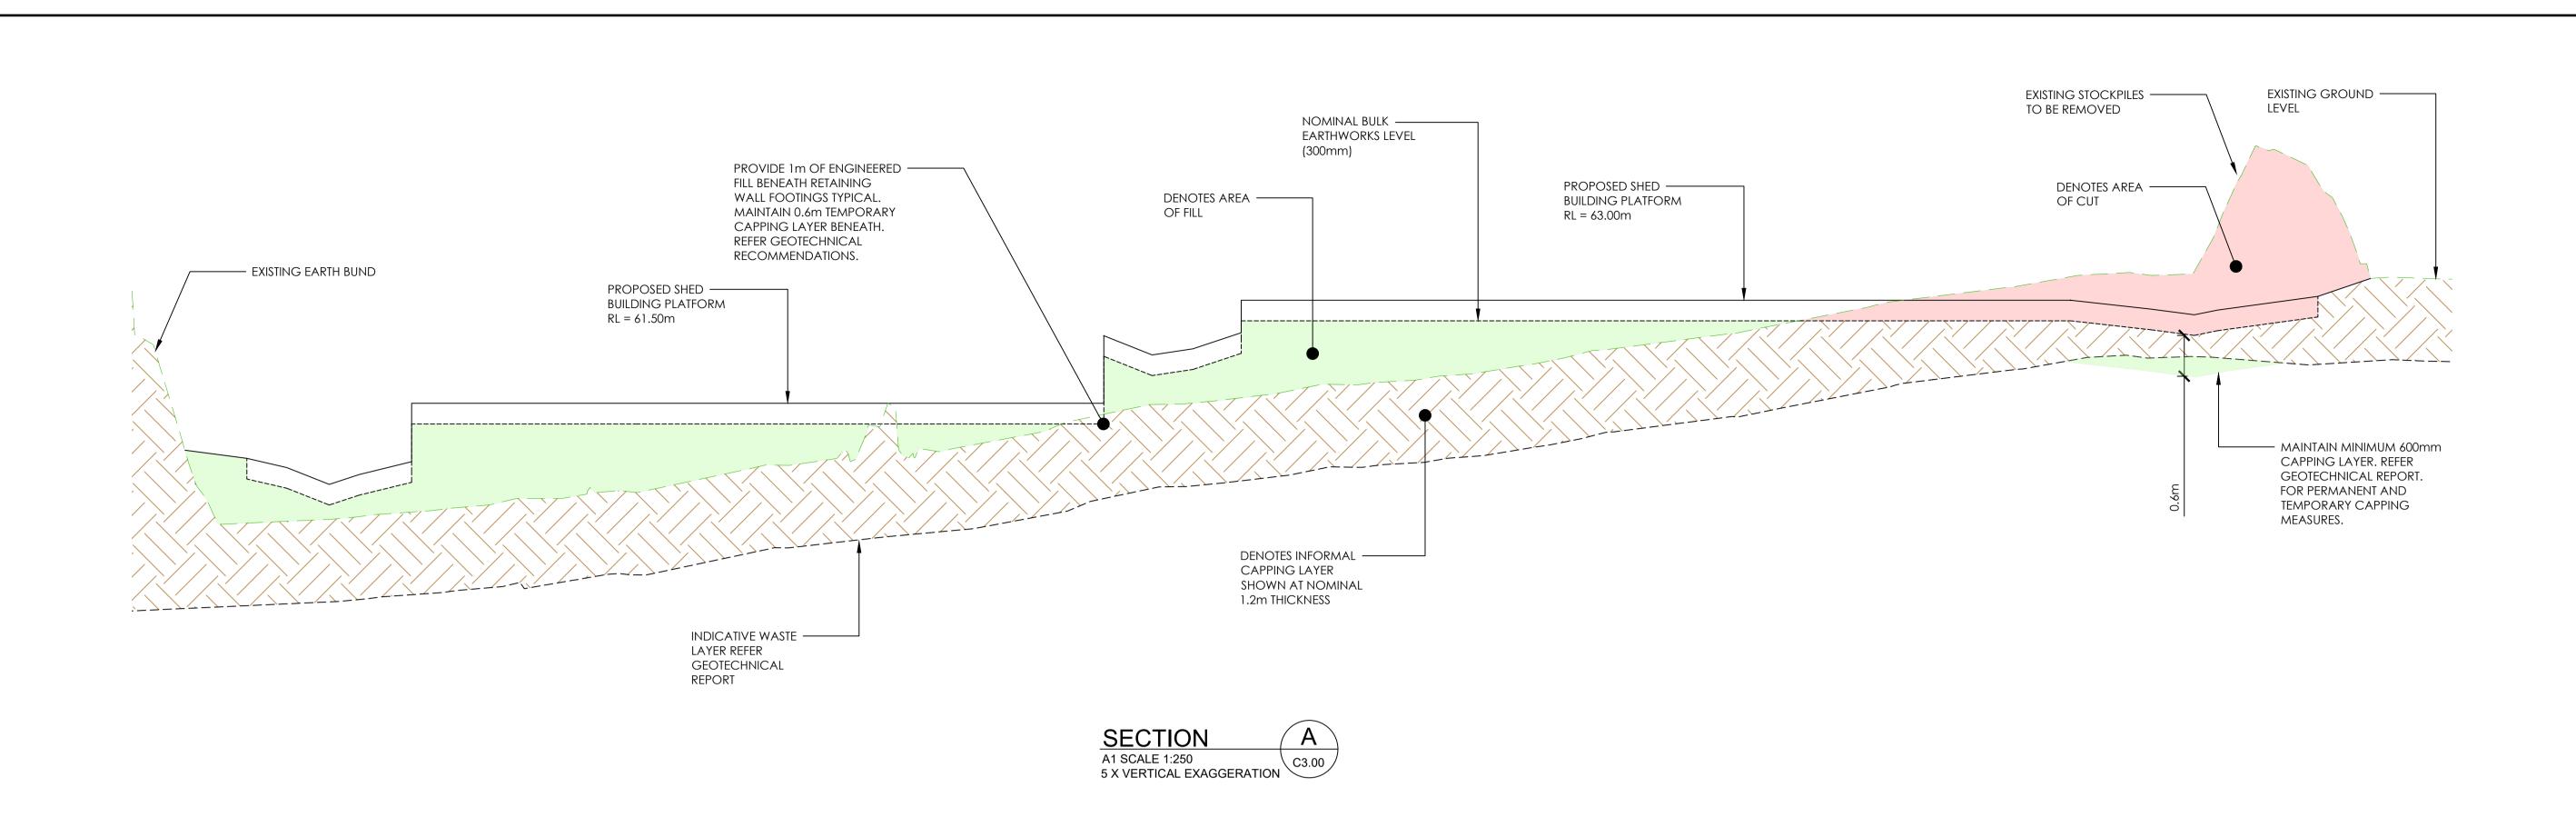FEB 23

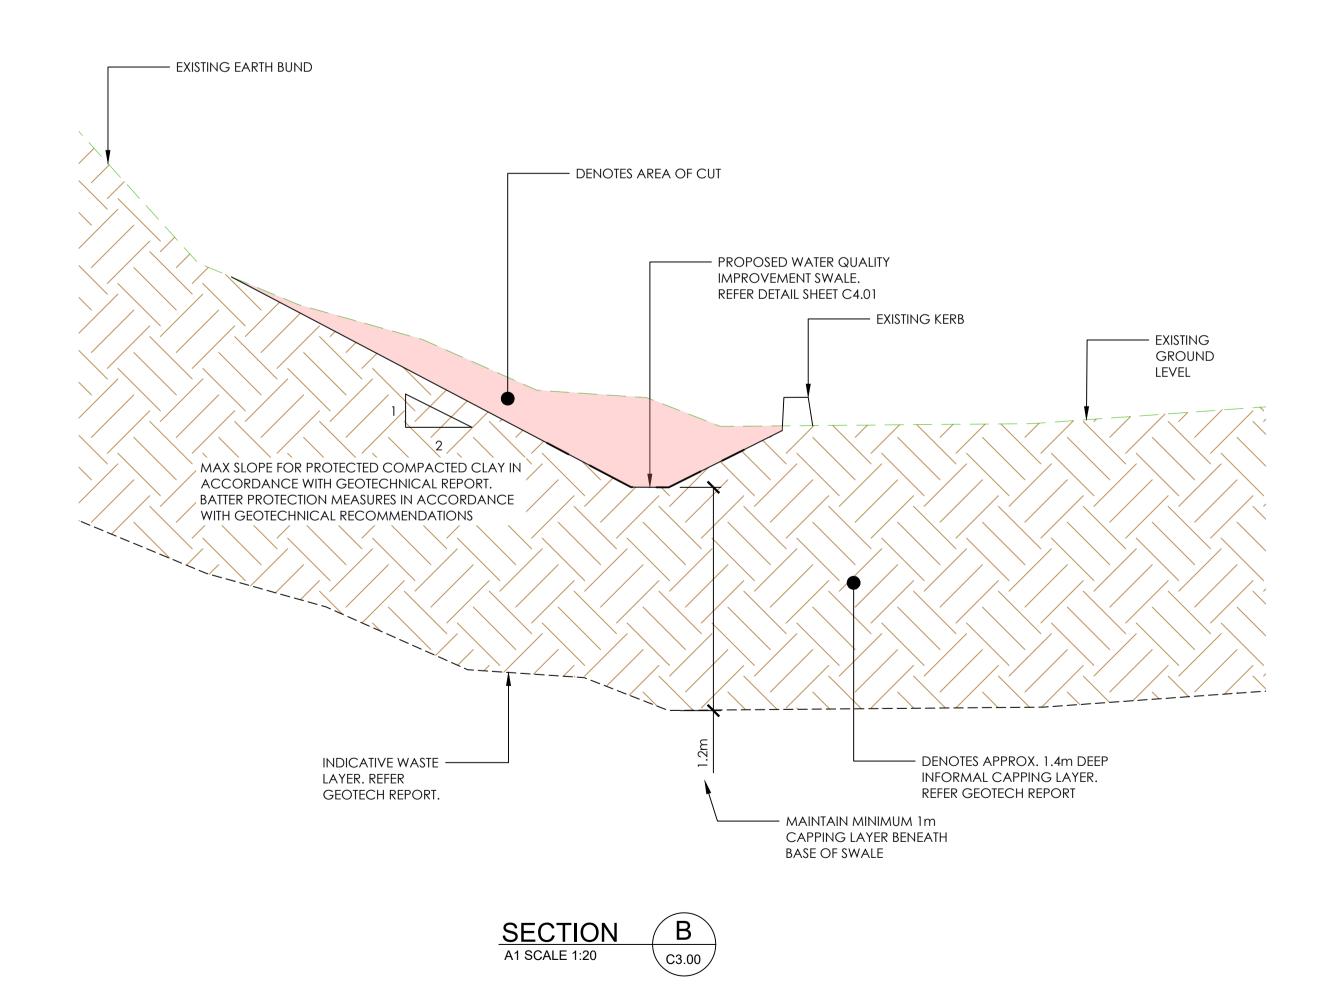SIZE CAD REF

TX16593.00 - C3

A1

DRAWN

IS.O

DESIGNED

TRIAXIAL
CONSULTING
COMPLEX PROBLEMS
RESOLVED SIMPLY

TRIAXIA L


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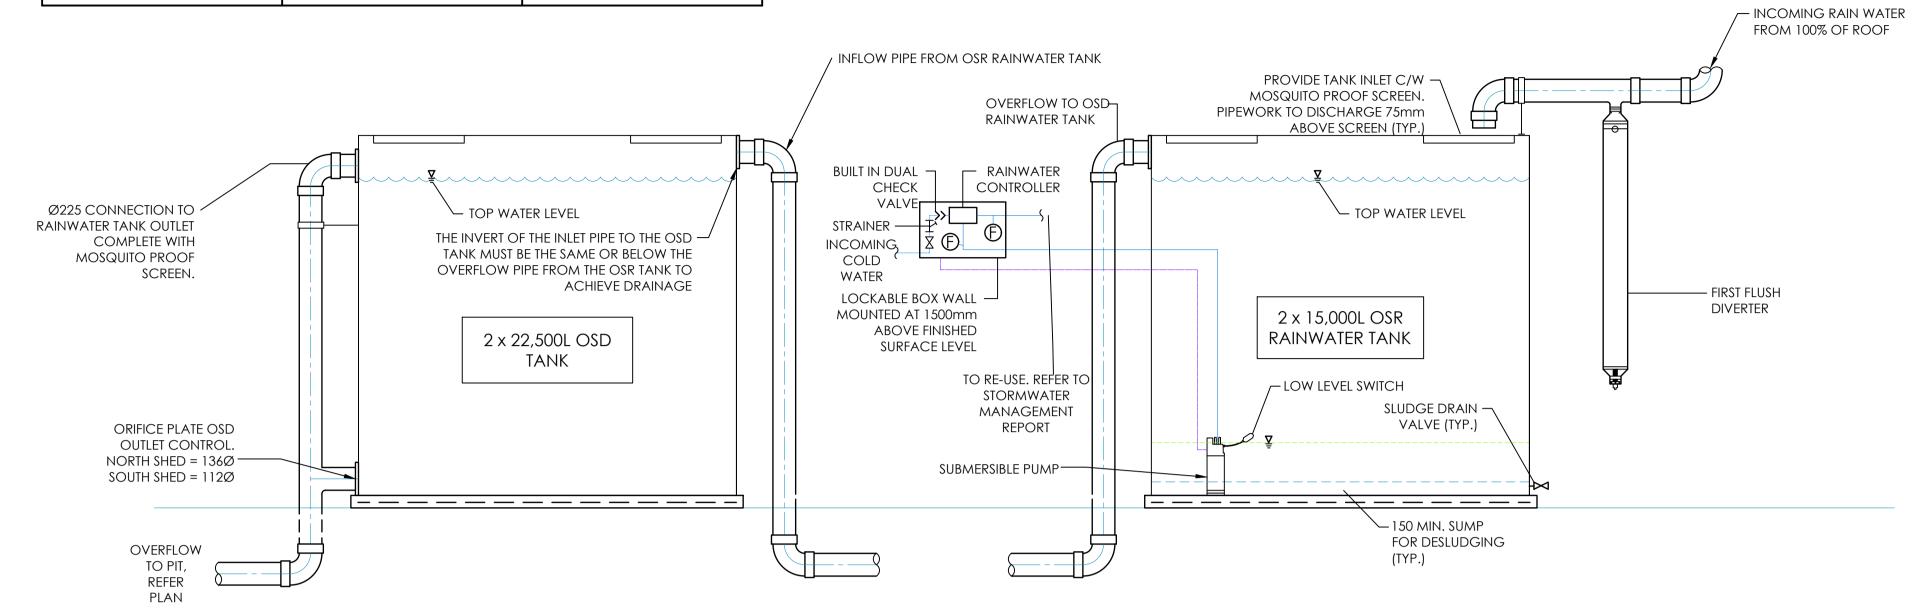
CONCEPT BULK EARTHWORKS
PLAN


TX16593.00 - C3.01 B



OSD SUMMARY			
STORM (AEP %)	PRE-DEVELOPMENT PEAK RUNOFF (L/sec.)	POST-DEVELOPMENT PEAR RUNOFF (L/sec.)	
20	114	114	
10	154	151	
5	196	185	
2	256	254	
1	306	306	

WATER QUALITY MODELLING RESULTS			
POLLUTANT	TARGET (%)	DESIGN REDUCTION (%)	
GP	90	100	
TSS	85	94.1	
TN	45	55.4	
TP	60	74.7	

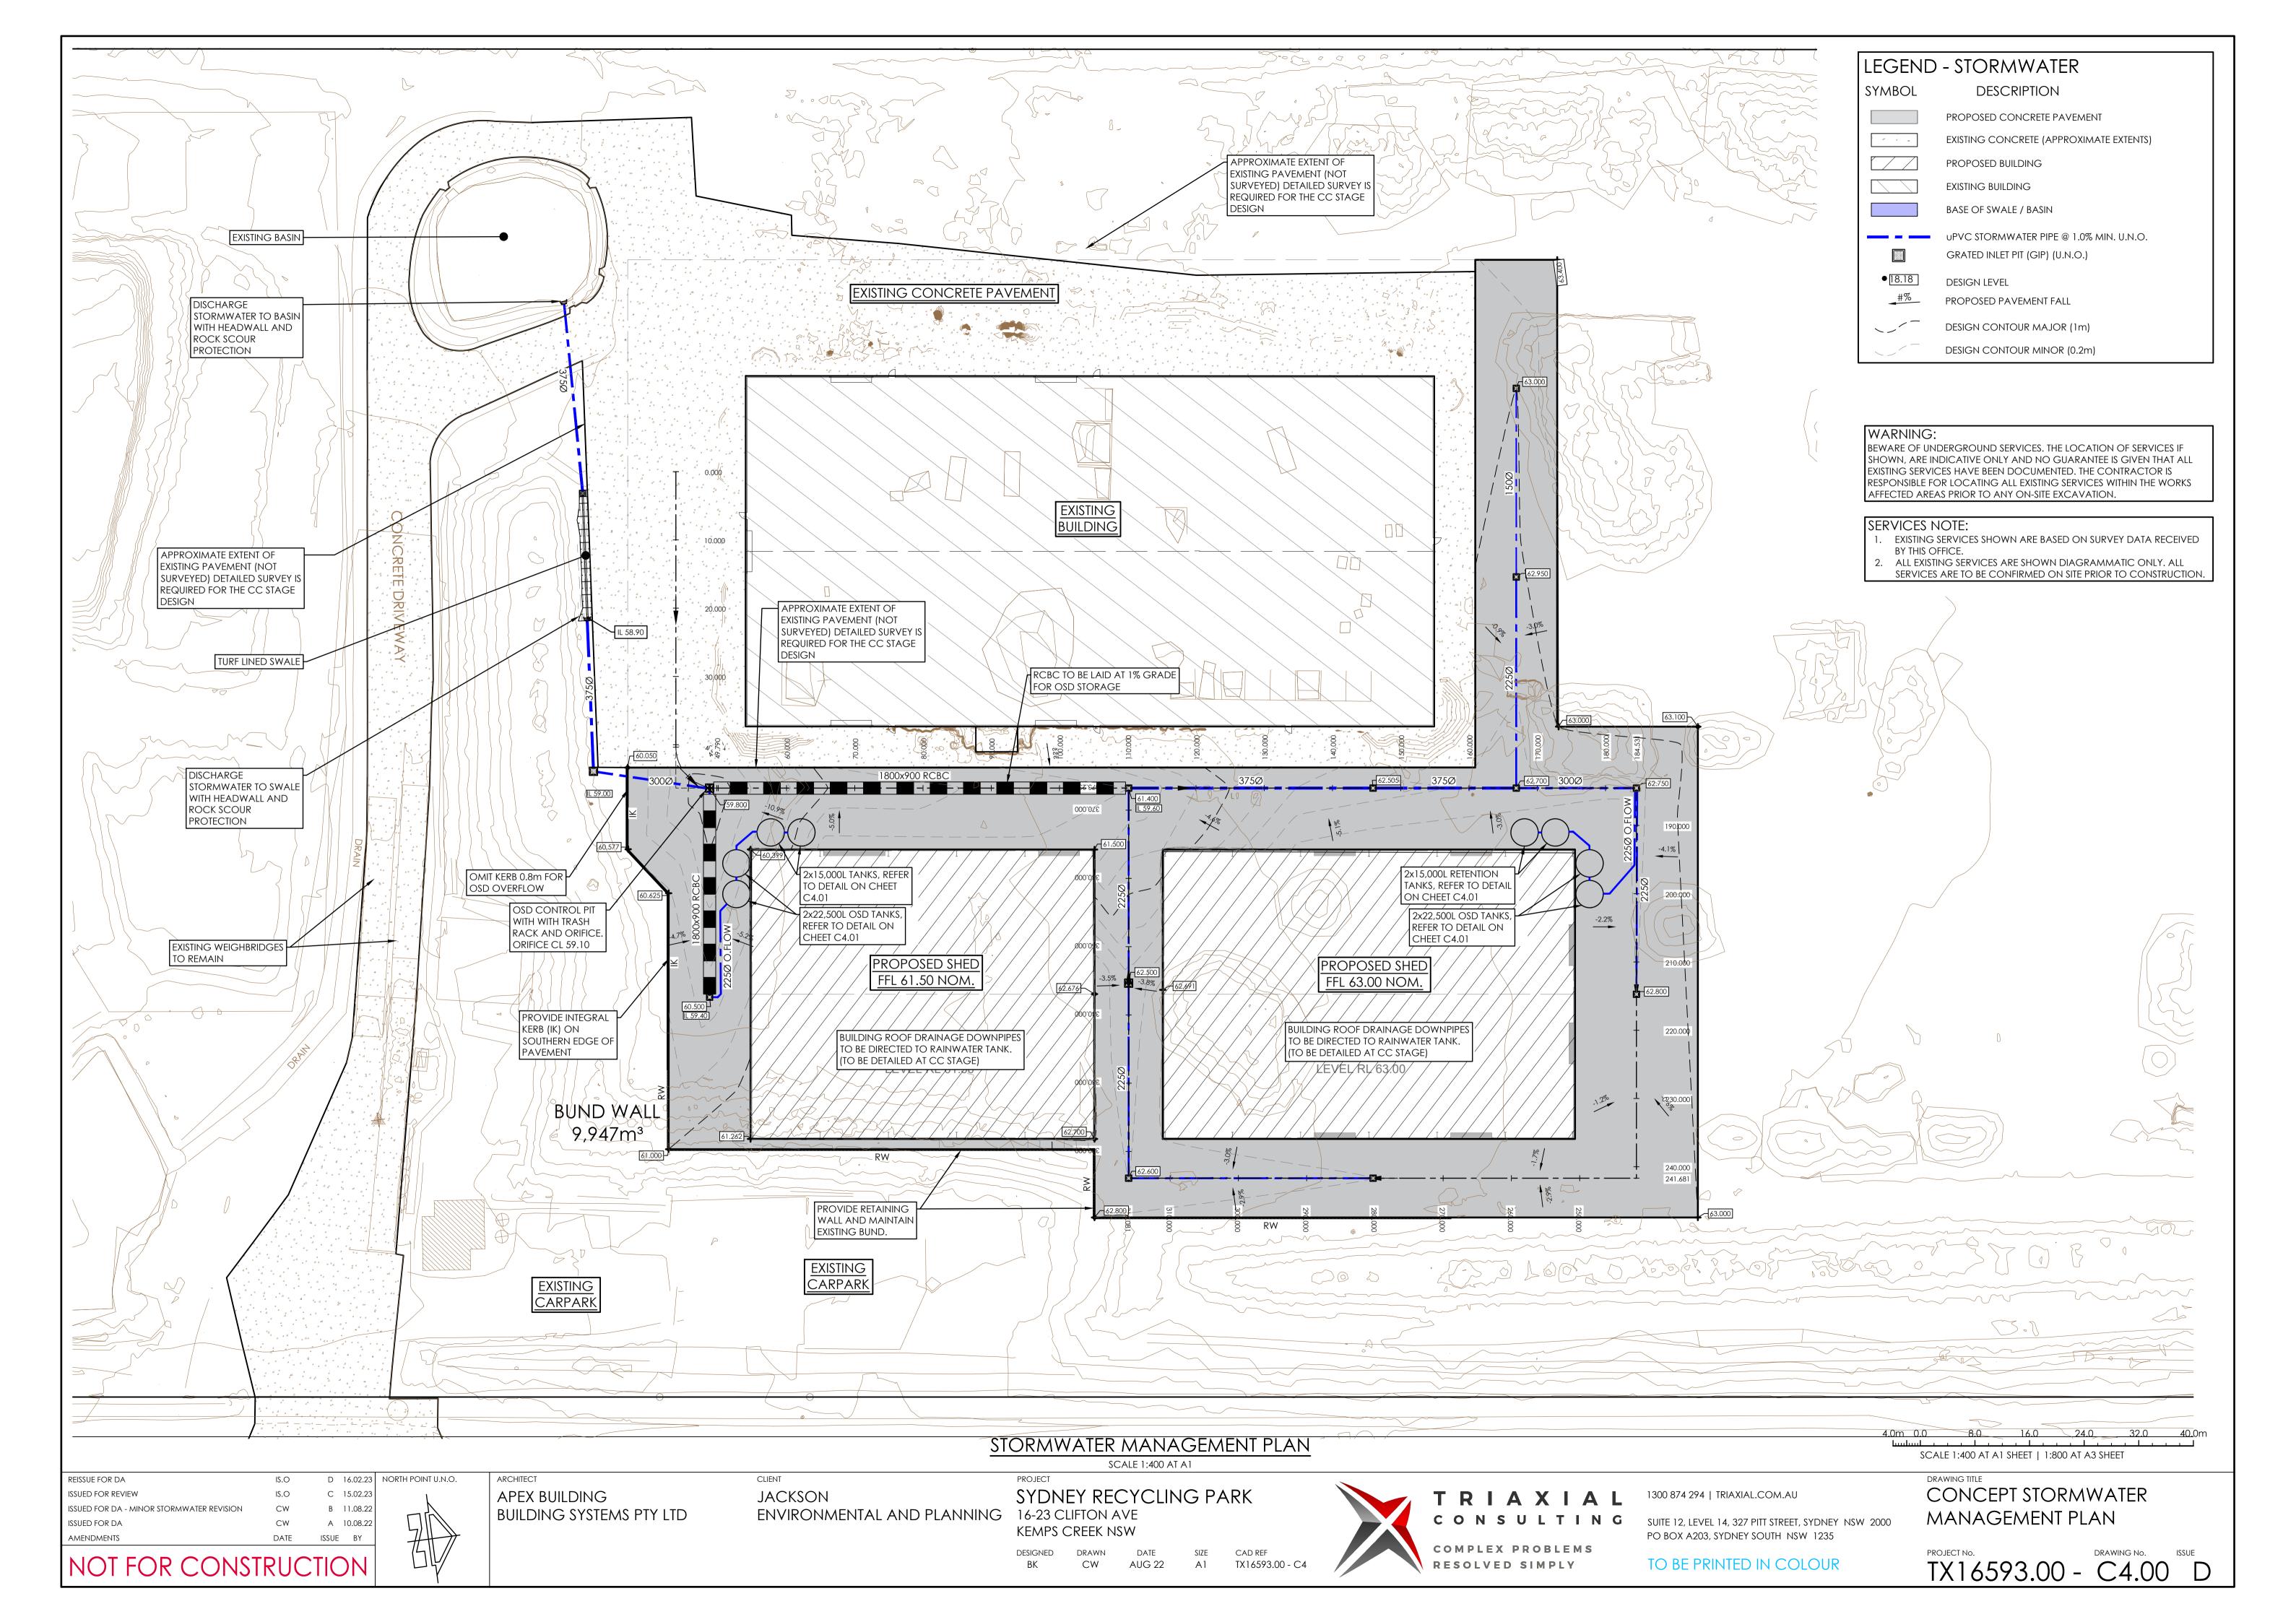


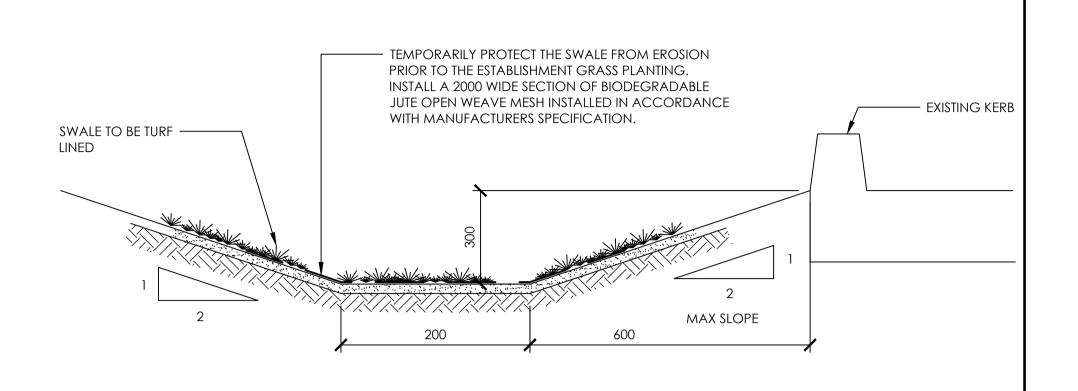

GRASSED LINED SWALE

SCALE 1:10 (A1)


### RAINWATER RE-USE AND OSD TANKS DETAIL N.T.S.

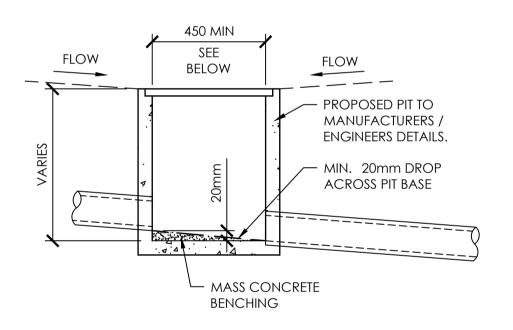


# TYPICAL GRATED SURFACE INLET


### PIT DETAIL

450 X 450 PLAN INTERNAL PIT DIMENSIONS FOR PITS LESS THAN 600 DEEP 600 X 600 PLAN INTERNAL PIT DIMENSIONS FOR PITS LESS THAN 900 DEEP 600 X 900 PLAN INTERNAL PIT DIMENSIONS FOR PITS 900 TO 1200 DEEP **NOTE:** STORMWATER PITS LESS THAN 600 SQUARE AND 600 DEEP MAY BE REPLACED WITH PLASTIC PITS IF NOT LOCATED IN ROADWAYS AND WRITTEN PERMISSION IS OBTAINED FROM THE ENGINEER.

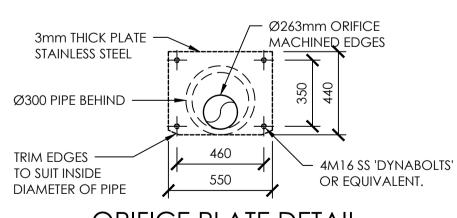



ORIFICE PLATE DETAIL SCALE 1:20 AT A1

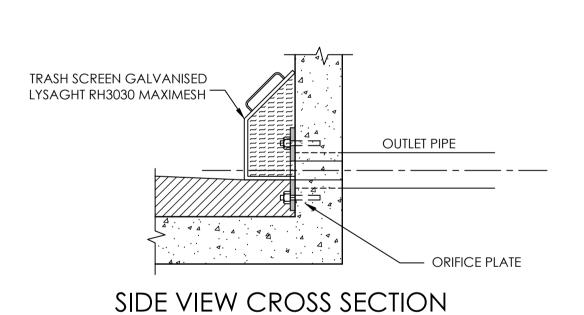

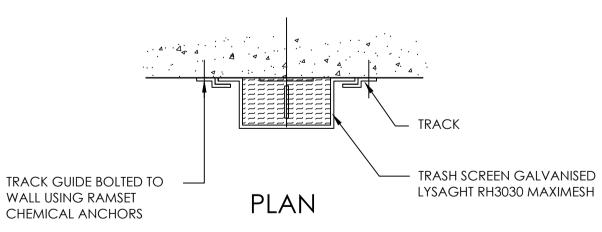

MAXIMESH TRASH SCREEN DETAIL SCALE NTS

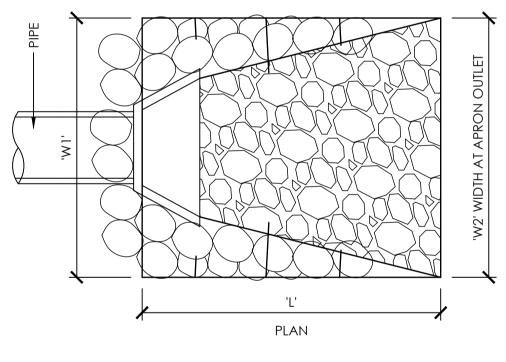

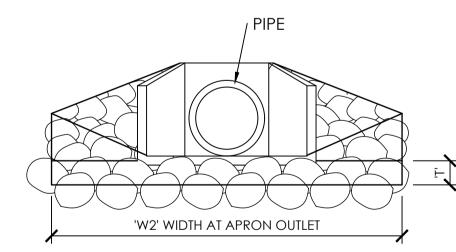

# ROCK SCOUR PROTECTION HEADWALL DETAIL

**ELEVATION** 

### ROCK SCOUR SCHEDULE

DESCRIPTION	ROCK	SIZES		W1	W2	THICKNESS
BEGGINI ITOTY	D <sub>50</sub>	D <sub>10</sub>	_	,,,,	W2 TBC	T
OUTLET	TBC	TBC	TBC	TBC	TBC	TBC

10mm 0 10 20 30 40 50 60 70 80 90 100mm

SCALE 1:1 AT A1 SHEET | 1:2 AT A3 SHEET

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DESIGNED DRAWN SIZE CW AUG 22 A1 TX16593.00 - C2



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CONCEPT STORMWATER MANAGEMENT DETAILS

TX16593.00 - C4.01

